

ALL CONTRACTORS TO VERIFY ALL
DIMENSIONS ON SITE & TO REPORT ALL
ERRORS AND/OR OMISSIONS TO THE
DESIGNER. ALL CONTRACTORS MUST
COMPLY WITH ALL CODES, BYLAWS & OTHER
AUTHORITIES HAVING JURISDICTION
OVER THE WORK.

ALL DIMENSIONS AND CONDITIONS TO BE VERIFIED ON SITE, FIGURED DIMENSIONS TAKE PRECEDENCE OVER SCALE. DO NOT SCALE DRAWINGS



SOLSTICE HOME DESIGN

2 Holcomb Ter, Waterdown, ON L8B 1Z8 (289) 680-7460 brian.rintjema@gmail.com



The undersigned has reviewed and takes responsibility for this design, and has the qualifications and meets the requirements set out in the Ontario Building Code to design the work shown on the attached documents.



Brian's Drafting Service 113224

FEDDEMA RESIDENCE

7125 Yonge St. Smithville, ON LOR 2A0


PAGE TITLE:

FOUNDATION PLAN


PLOT FORMAT SIZE: DRAWN BY: 24 X 36 Brian Rintjema

APRIL 30, 2024

SHEET NO.

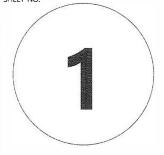



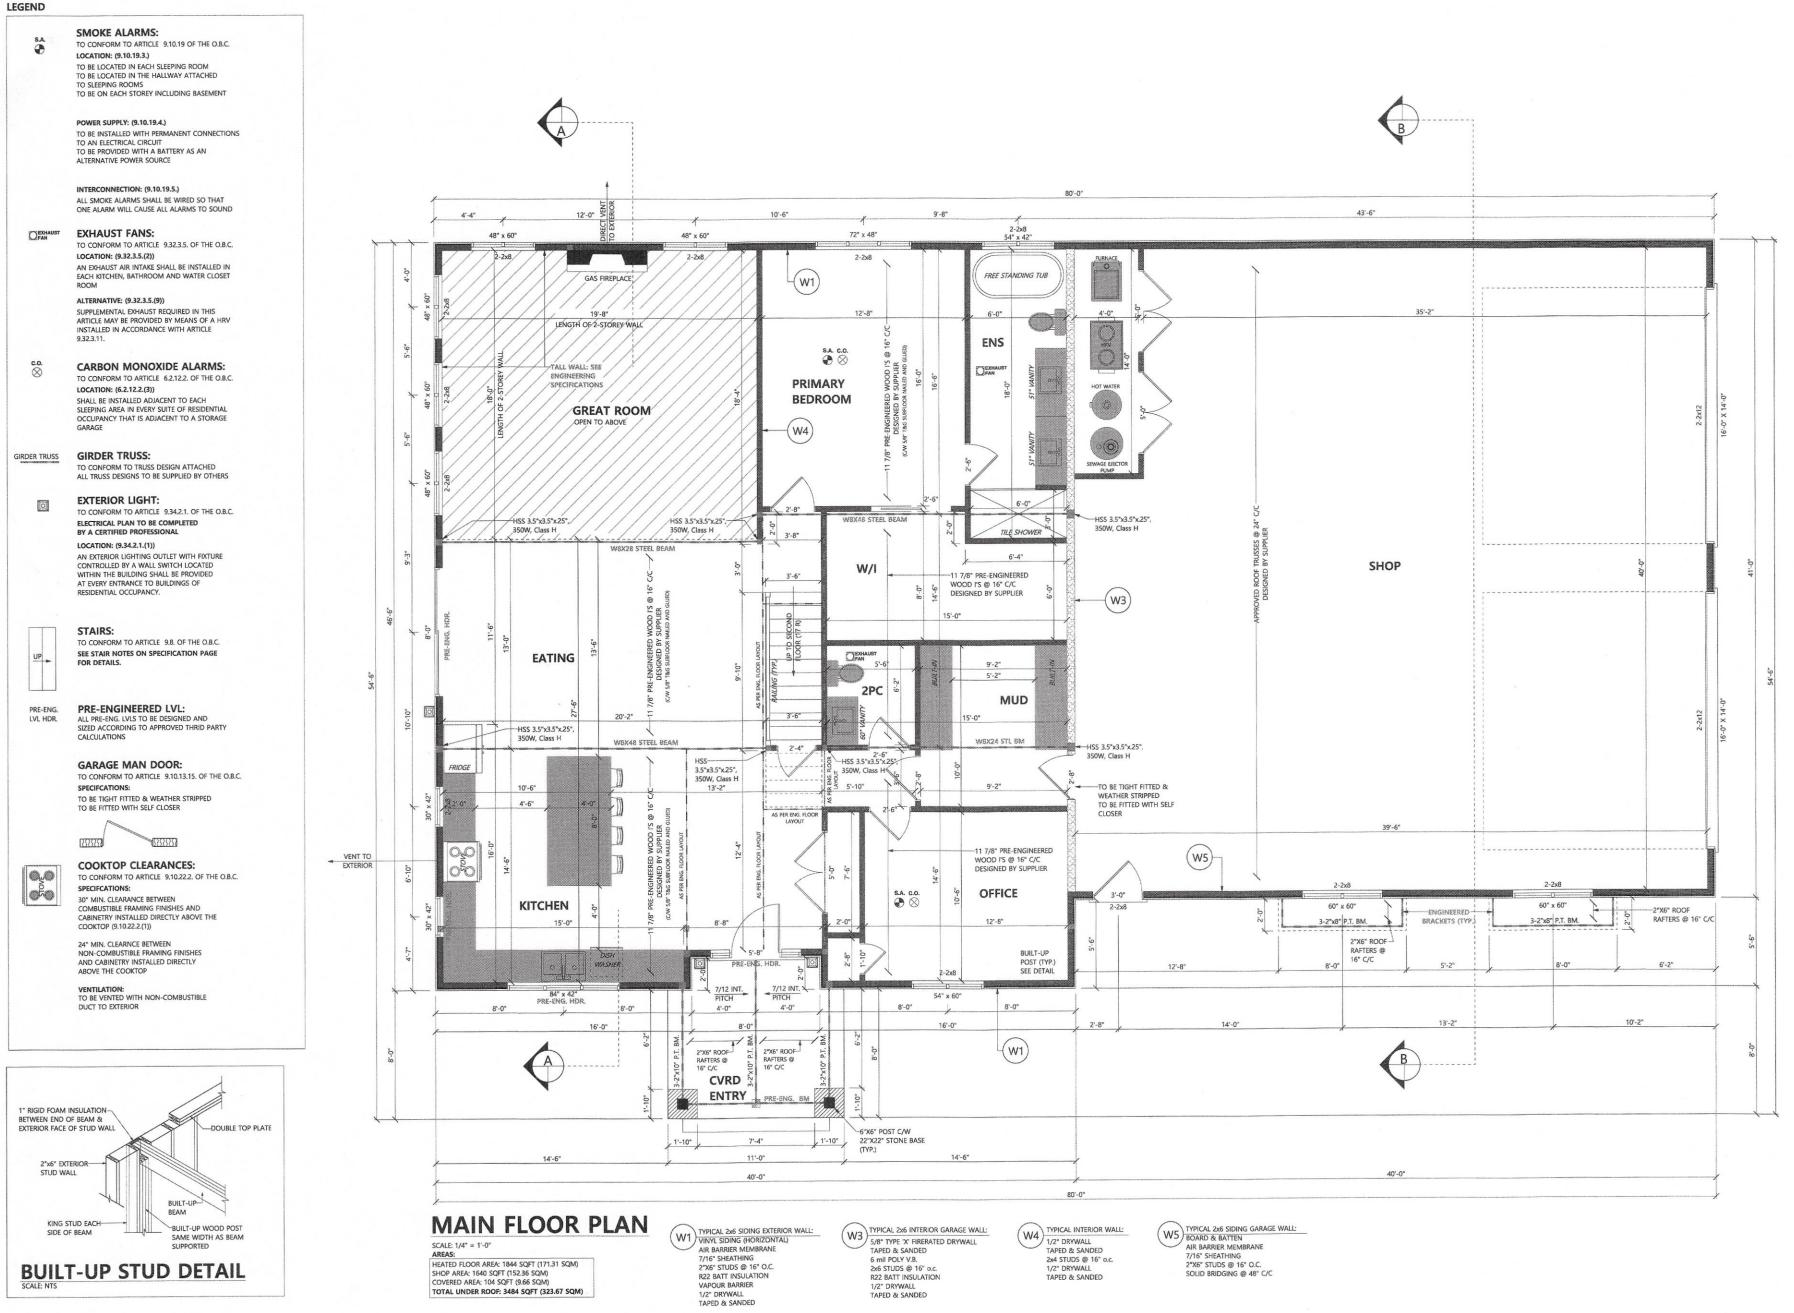

WOOD LINTEL SCHEDULE (SPF) SPAN WALL 2(2X8) 2(2X10) EXT. 6'-7" 8'-1" HIP END INT. 5'-4" 6'-7" EXT. 15'-1" 18'-10" GABLE END INT. 12'-8" 16'-3" EXT. 5'-5" 6'-8" +1 STOREY INT. 3'-11" 4'-9" EXT. 5'-0" 6'-1" EXT. 4'-8" 5'-8" +3 STOREY INT. 3'-2" 3'-10"

ALL CONTRACTORS TO VERIFY ALL DIMENSIONS ON SITE & TO REPORT ALL ERRORS AND/OR OMISSIONS TO THE DESIGNER. ALL CONTRACTORS MUST COMPLY WITH ALL CODES, BYLAWS & OTHER AUTHORITIES HAVING JURISDICTION OVER THE WORK.

ALL DIMENSIONS AND CONDITIONS TO BE VERIFIED ON SITE. FIGURED
DIMENSIONS TAKE PRECEDENCE OVER SCALE. DO NOT SCALE DRAWINGS



SOLSTICE HOME DESIGN

> Waterdown, ON L8B 1Z8 (289) 680-7480

> brian.rintjema@gmail.com



The undersigned has reviewed and takes responsibility for this design, and has the qualifications and meets the Building Code to design the work



Registration Information Brian's Drafting Service 113224

> **FEDDEMA** RESIDENCE

7125 Yonge St. Smithville, ON LOR 2A0

PAGE TITLE:


MAIN FLOOR **PLAN**


PLOT FORMAT SIZE: DRAWN BY: 24 X 36 Brian Rintjema


SCALE:

SHEET NO.


APRIL 30, 2024 As Noted

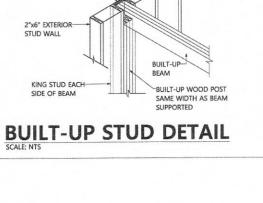

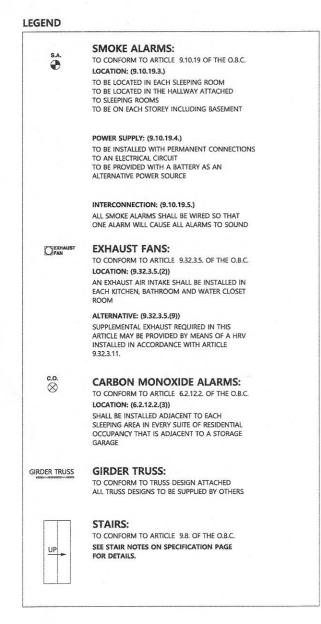

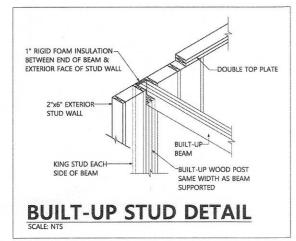

v	VOOD LINTEL	SCHED	ULE (SP	F)
CONDITION/LOAD		SPAN		
		WALL	2(2X8)	2(2X10)
ROOF	HIP END	EXT.	6'-7"	8'-1"
		INT.	5'-4"	6'-7"
	GABLE END	EXT.	15'-1"	18'-10"
		INT.	12'-8"	16'-3"
ROOF + CIEILING	+1 STOREY	EXT.	5'-5"	6'-8"
		INT.	3'-11"	4'-9"
	+2 STOREY	EXT.	5'-0"	6'-1"
		INT.	3'-5"	4'-2"
	+3 STOREY	EXT.	4'-8"	5'-8"
		INT.	3'-2"	3'-10"

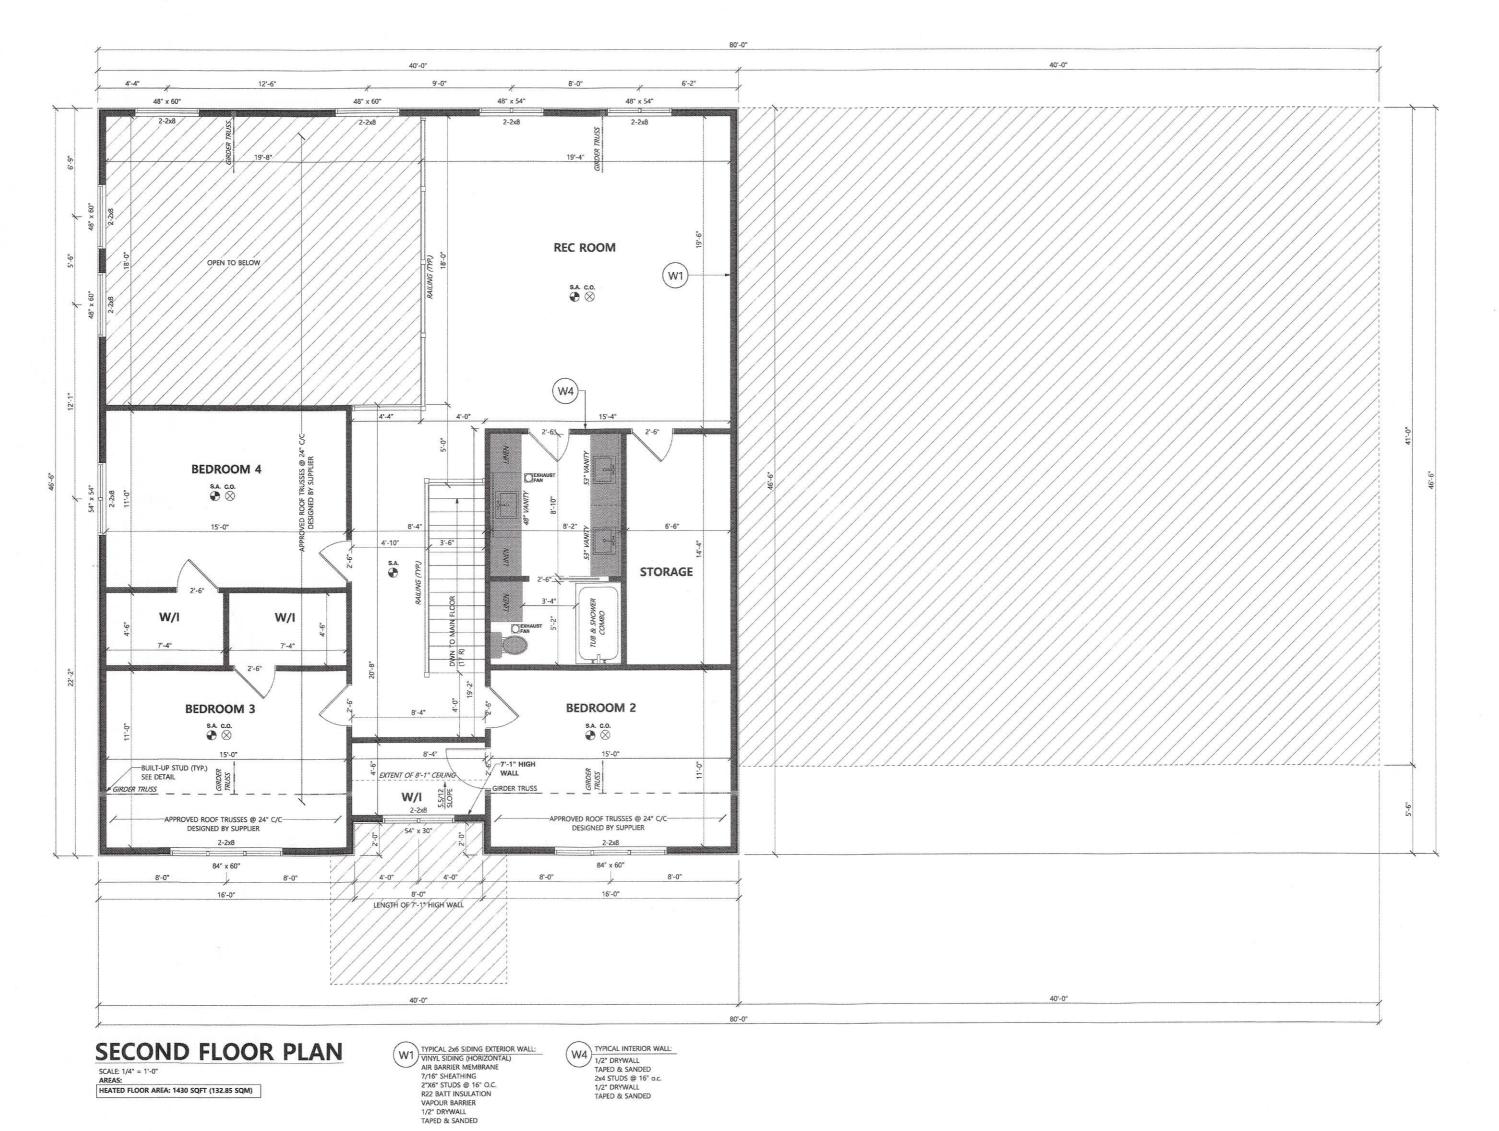

ALL CONTRACTORS TO VERIFY ALL
DIMENSIONS ON SITE & TO REPORT ALL
ERRORS AND/OR OMISSIONS TO THE
DESIGNER. ALL CONTRACTORS MUST
COMPLY WITH ALL CODES, BYLAWS & OTHER
AUTHORITIES HAVING JURISDICTION
OVER THE WORK.

ALL DIMENSIONS AND CONDITIONS TO BE VERIFIED ON SITE. FIGURED DIMENSIONS TAKE PRECEDENCE OVER SCALE. DO NOT SCALE DRAWINGS



SOLSTICE HOME DESIGN

> 2 Holcomb Ter, Waterdown, ON L88 1Z8 (289) 680-7480 brian.rintjema@gmail.com



The undersigned has reviewed and takes responsibility for this design, and has the qualifications and meets the requirements set out in the Ontario Building Code to design the work shown on the attached documents.



Registration Information

Brian's Drafting Service 113224

Firm BCIN

FEDDEMA

RESIDENCE

7125 Yonge St. Smithville, ON LOR 2A0

PAGE TITLE:

SECOND FLOOR PLAN

PLOT FORMAT SIZE:

24 X 36

DATE:

APRIL 30, 2024

DRAWN BY:

Brian Rintjema

SCALE:

As Noted

SHEET NO.


3



TRUSS NOTE:

TRUSS MANUFACTURER TO PROVIDE TRUSS LAYOUT AND COMPONENT DETAILS TO THE DESIGNER PRIOR TO FABRICATION. CONTRACTOR MUST VERIFY WITH THE DESIGNER THAT THE STRUCTURE AND TRUSS LAYOUT HAS BEEN COORDINATED AND REVIEWED BY THE DESIGNER PRIOR TO COMMENCEMENT OF THE WOOD FRAMING WORK.

THE DESIGNER HAS ENGINEERED THE DESIGN OF THE SUPERSTRUCTURE SUPPORTING ALL ENGINEERED TRUSSES. GRAVITY LOADING TRANSFERRED BY THE ROOF TRUSS SYSTEM HAS BEEN CONSIDERED BY THE DESIGNER AS REQUIRED IN OBC SECTION 9.4. IT IS THE DESIGNER AS REQUIRED IN OBC SECTION 9.4. IT IS THE RESPONSIBILITY OF THE ROOF TRUSS DESIGNER/
SUPPLIER TO PROVIDE THE ENGINEERING FOR ALL PROPRIETARY TRUSS COMPONENTS - I.E. CHORDS, LATERAL WEB & CHORD BRACING FOR BUCKLING AND ANY RELATED LATERAL RESTRAINTS NEEDED THAT COULD BE TRANSFERRED BY THE RESULTANT FORCES WITHIN THE TRUSS MEMBERS.
ENGINEERING AND SPECIFICATIONS FOR TRUSSES TO BE ON SITE AT TIME OF FRAMING INSPECTION.

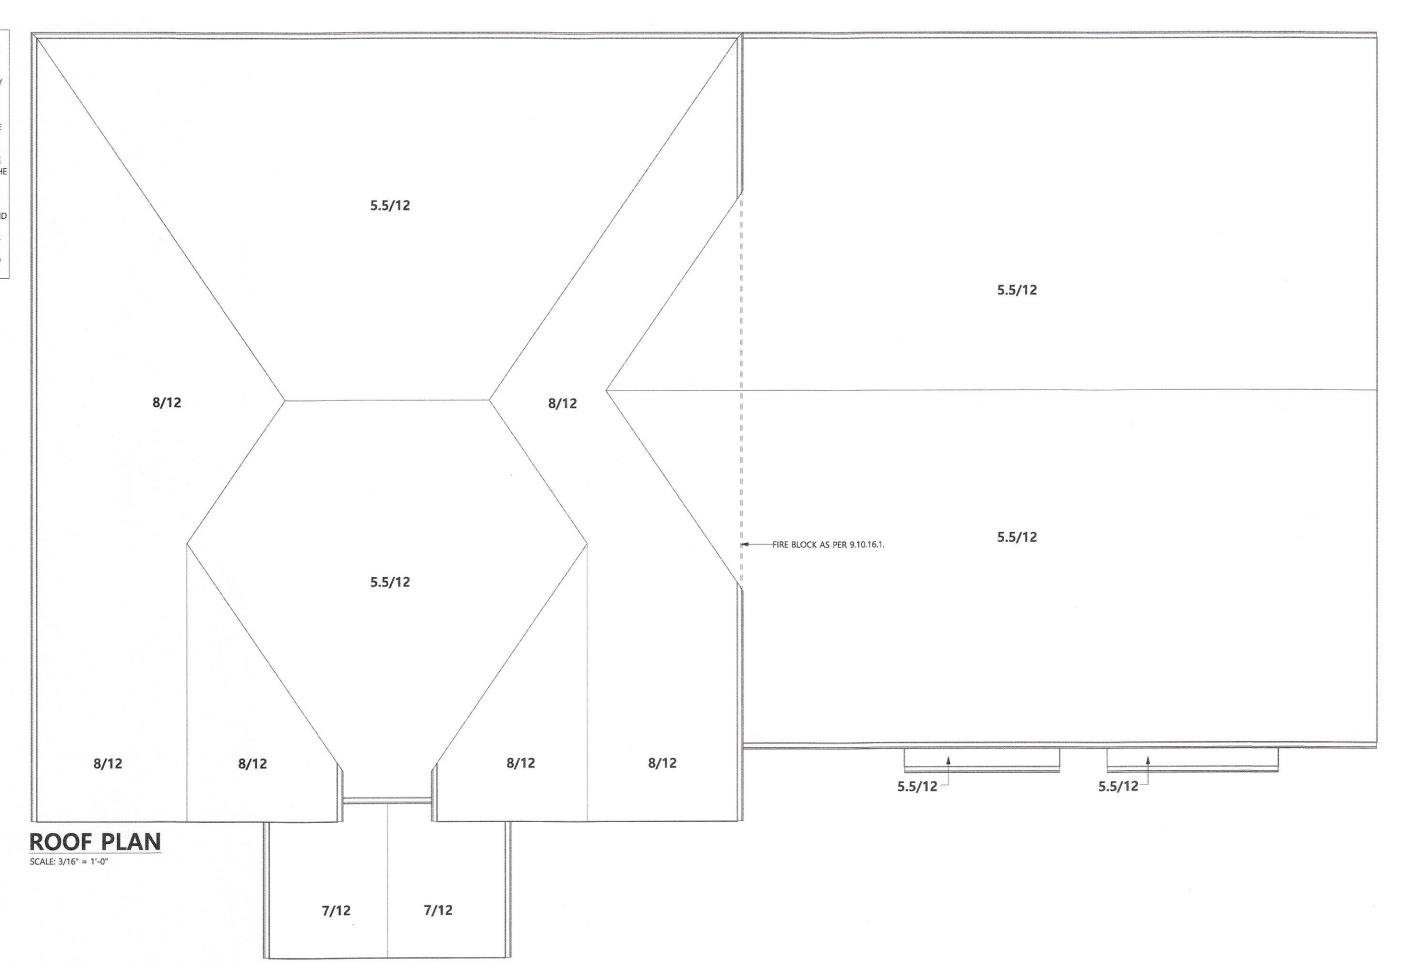


ALL CONTRACTORS TO VERIFY ALL
DIMENSIONS ON SITE & TO REPORT ALL
ERRORS AND/OR OMISSIONS TO THE
DESIGNER. ALL CONTRACTORS MUST
COMPLY WITH ALL CODES, BYLAWS & OTHER
AUTHORITIES HAVING JURISDICTION
OVER THE WORK.

ALL DIMENSIONS AND CONDITIONS TO BE VERIFIED ON SITE. FIGURED DIMENSIONS TAKE PRECEDENCE OVER SCALE. DO NOT SCALE DRAWINGS



2 Holcomb Ter, Waterdown, ON L8B 1Z8 (289) 680-7480

brian.rintjema@gmail.com

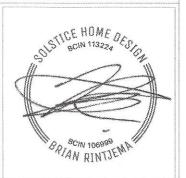

The undersigned has reviewed and takes responsibility for this design, and has the qualifications and meets the requirements set out in the Ontario Building Code to design the work shown on the attached documents.



Brian's Drafting Service 113224

FEDDEMA

RESIDENCE 7125 Yonge St. Smithville, ON LOR 2A0


PAGE TITLE:


ROOF PLAN


As Noted APRIL 30, 2024

SHEET NO.



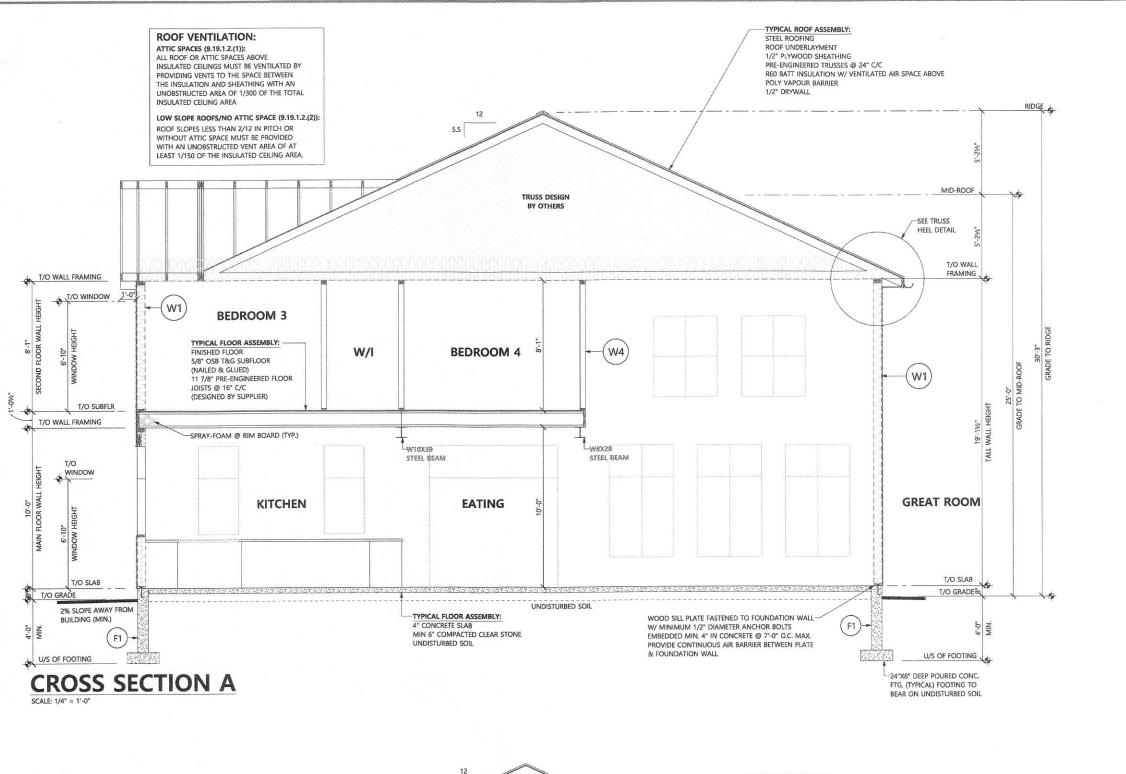

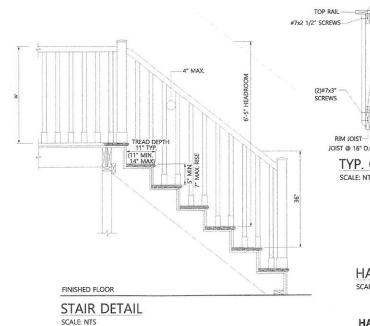

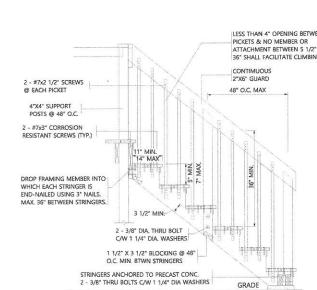

EXTERIOR STAIR DETAIL SCALE: NTS



RIM JOIST-JOIST @ 16° O.C.-TYP. GUARD CONNECTION

#7x3" SCREWS @ 12" O.C.

-2"x4" RAIL

HANDRAIL DETAIL

SCALE: NTS

CONTINUITY:

HANDRAILS: TO CONFORM TO ARTICLE 9.8.7. IN THE OBC

HANDRAILS SHALL BE CONSTRUCTED WITH NO OBSTRUCTION ON OR ABOVE THEM TO BREAK A HANDHOLD EXCEPT WHERE THE HANDRAILS ARE INTERRUPTED BY DOORWAYS AND NEWELS AT CHANGES IN DIRECTION LOCATION: ANDRAILS REQUIRED ON: ONE SIDE OF STAIRS LESS THAN 3'-7" WIDE TWO SIDES OF STAIRS 3'-7" WIDE OR GREATER

ATTACHMENT: DESIGN AND ATTACHMENT OF HANDRAILS MUST CONFORM TO ARTICLE 9.8.7.7. HANDRAILS SHALL BE:

ATTACHED TO WOOD STUDS OR BLOCKING IS LOCATED NOT MORE THAN 11 3/4" FROM THE END OF THE HANDRAIL SOLID WOOD HEIGHT OF HANDRAILS MUST BE NO LESS THAN 2'-10" AND NOT MORE THAN 3'-2" MEASURED VERTICALLY FROM A LINE DRAWN GUARDS: TO CONFORM TO ARTICLE 9.8.8. IN THE OBC

WHEN AN INTERIOR STAIR HAS MORE THAN 2 RISERS, THE SIDES OF THE STAIR AND THE LANDING OR FLOOR LEVEL AROUND THE STAIR WELL SHALL BE ENCLOSED BY WALL OR PROTECTED BY

ALL CONTRACTORS TO VERIFY ALL

DIMFNSIONS ON SITE & TO REPORT ALL

ERRORS AND/OR OMISSIONS TO THE

DESIGNER. ALL CONTRACTORS MUST

COMPLY WITH ALL CODES, BYLAWS & OTHER

AUTHORITIES HAVING JURISDICTION

OVER THE WORK.

ALL DIMENSIONS AND CONDITIONS TO BE

VERIFIED ON SITE, FIGURED

DIMENSIONS TAKE PRECEDENCE OVER SCALE.

DO NOT SCALE DRAWINGS

SOLSTICE

HOME DESIGN

Waterdown, ON L8B 1Z8

(289) 680-7480

brian.rintjema@gmail.com

STICE HOME DESTER

ements set out in the Ontario

Registration Information

Brian's Drafting Service 113224

FEDDEMA

RESIDENCE

CROSS

SECTIONS &

SPECS

7125 Yonge St. Smithville, ON LOR 2A0

PAGE TITLE:

INTERIOR STAIRS AND LANDINGS: 36" MINIMUM HEIGHT EXTERIOR STAIRS AND LANDINGS: 42" MINIMUM HEIGHT

OPENINGS THROUGH A GUARD MUST PREVENT THE PASSAGE OF A 4" DIAMETER SPHERE

GUARDS MUST BE DESIGNED SO THAT NO MEMBER ATTACHMENT OR OPENING 6" - 24" ABOVE FLOOR LEVEL WILL FACILITATE CLIMBING

STAIRS: TO CONFORM TO ARTICLE 9.8. OF THE O.B.C.

CLEAR HEIGHT CLEAR HEIGHT OVER STAIRS IS MEASURED VERTICALLY FROM A LINE DRAWN THROUGH THE OUTER EDGES OF THE NOSINGS

CLEAR HEIGHT MUST NOT BE LESS THAN 6'-5"

STAIR TOLERANCES
DIFFRENCE BETWEEN GREATEST AND SMALLEST
TREAD DEPTH WITHIN A FLIGHT OF STAIRS IS
LIMITED TO 3/8"

DIFFERENCE BETWEEN HIGHEST AND LOWEST RISERS WITHIN A FLIGHT OF STAIRS IS LIMITED TO 3/8"

DIFFERENCE FOR TREAD DEPTH OR RISER HEIGHT FOR ADJACENT STAIRS CANNOT EXCEED 3/16"

MAXIMUM DEPTH OF BEVELED OR ROUNDED EDGE IS 1"

ROUNDED OR BEVELED LEADING EDGES OF TREADS CAN NOT REDUCE THE REQUIRED TREAD DEPTH BY MORE THAN 5/8"

TO HAVE A MINIMUM EFFECTIVE (CUT) DEPTH OF 3
1/2" MEASURED PERPENDICULARLY TO THE BOTTOM
OF THE STRINGER AT THE POINT OF MIN. CROSS

ATTACHMENT POINTS ARE SPACED NOT MORE THAN 3'-11" APART
THE FIRST ATTACHMENT POINT AT EITHER END TO HAVE AN OVERALL DEPTH OF NOT LESS THAN 9 TO BE SUPPORTED AND SECURED TOP AND BOTTOM THE FASTENERS CONSIST OF NO FEWER THAN 2 WOOD SCREWS AT EACH POINT PENETRATING NOT LESS THAN 1 1/4" INTO TO BE NOT LESS THAN 1 1/2" THICK TO BE SPACED NOT MORE THAN 2'-11" O.C. TO BE NOT LESS THAN 1° THICK FINISHES SHALL BE SLIP RESISTANT FINSHES TO COMPLY WITH SENTENCE 9.8.9.6.(2) THROUGH THE LEADING EDGES OF STAIR TREADS TO THE TOB OF THE HANDRAIL EXTERIOR STEPS The undersigned has reviewed and HANDRAIL PROJECTIONS: takes responsibility for this design, and has the qualifications and meets the EXTERIOR WOOD STEPS MUST NOT BE IN DIRECT 2" MIN. (WALL TO INSIDE OF HANDRAIL) 4" MAX. (WALL TO OUSIDE OF HANDRAIL) Building Code to design the work shown on the attached documents. GRAB BAR REINFORCEMENT:

TYPICAL ROOF ASSEMBLY: STEEL ROOFING ROOF UNDERLAYMENT 1/2" PLYWOOD SHEATHING PRE-ENGINEERED TRUSSES @ 24" C/C TRUSS DESIGN SEE TRUSS HEEL T/O WALL FRAMING ENSURE T/O FACIA MATCHES T/O PER DRAWINGS WALL FRAMING TOP OF 2"X6" SUBFACIA-(W5) & T/O WALL FRAMING TO MATCH SOFFIT VENT IN PRE-FINISHED ALUM. EAVSTROUGH W/ HIP-END--WOOD SILL PLATE FASTENED TO FOUNDATION WALL CONTINUOUS LEAFGUARD W/ MINIMUM 1/2" DIAMETER ANCHOR BOLTS
EMBEDDED MIN. 4" IN CONCRETE @ 7'-0" O.C. MAX.
PROVIDE CONTINUOUS AIR BARRIER BETWEEN PLATE PRE-FINISHED METAL FACIA-OVER 2"x6" SUBFACIA T/O FOUNDATION O GRADE 2% SLOPE AWAY FROM BUILDING (MIN.) UNDISTURBED SOIL (F1) • TYPICAL GARAGE FLOOR CONSTRUCTION:
MIN. 5" CONC. SLAB WITH
6"x6" 6/6" WWM
MIN. 6" COMPACTED GRANULAR "A" BASE TRUSS HEEL DETAIL OBC: TABLE 9.23.10.1 (2) U/S OF FTG 3/8" OSB (MIN.)
SOLID BRIDGING @ 48" C/C
STUDS FASTED TO TOP PLATES WITH (3)3.25" TOE-NAILS (MIN.)
DOUBLE TO PLATES FASTENED TOGETHER WITH 3" NAILS @ 8" C/C (MIN.)
ROOF FRAMING MEMBERS @ 24" C/C (MAX.) FASTENED TO TOP PLATES WITH (4)3.25" TOE-NAILS (MIN.)
BOTTOM PLATE FASTED TO FLOOR JOISTS, BLOCKING OR RIM JOISTS WITH 3.25" NAILS @ 8" C/C (MIN.) 1" SAWCUTS @ 8'-0" O/C -24"X8" DEEP POURED CONC FTG. (TYPICAL) FOOTING TO BEAR ON UNDISTURBED SOIL **CROSS SECTION B**

TYPICAL 2x6 SIDING GARAGE WALL:
BOARD & BATTEN

2"X6" STUDS @ 16" O.C. SOLID BRIDGING @ 48" C/C

AIR BARRIER MEMBRANE

7/16" SHEATHING

F1 | 8" POURED CONCRETE 24"X8" CONCRETE FOOTING

F2 10" POURED CONCRETE 24"X8" CONCRETE FOOTING

TYPICAL 2x6 SIDING EXTERIOR WALL:
VINYL SIDING (HORIZONTAL)

AIR BARRIER MEMBRANE 7/16" SHEATHING 2"X6" STUDS @ 16" O.C.

R22 BATT INSULATION VAPOUR BARRIER 1/2" DRYWALL TAPED & SANDED

TYPICAL INTERIOR WALL:

1/2" DRYWALL


TAPED & SANDED

2x4 STUDS @ 16" o.c.

(a) FOR A WATER CLOSET AS DESCRIBED BY CLAUSE 3.8.3.8(3)(a) & 3.8.3.8(3)(c), (b) FOR A SHOWER AS DESCRIBED BY CLAUSE 3.8.3.13 (2)(g), and (c) FOR A BATHTUB AS DESCRIBED BY CLAUSE 3.8.3.13(4)(e). 361/2" WOUD BLOCKING
BETWEEN WALL STUDS NAILS OR SCREWS BOTH SIDES (TYP.) · 0 W.C. SIDE ELEVATION W.C. FRONT **ELEVATION** 3-3%" SPIRAL
NAILS OR SCREWS
BOTH SIDES (TYP.) **TUB WALL SIDE TUB END WALL ELEVATION ELEVATION** (BOTH SIDES) 15%"-19%" 39%"

ONTARIO BUILDING CODE REFERENCE - 9.5.2.3 STUD WALL REINFORCEMENT
(1) IF WOOD WALL STUDS OR SHEET STEEL WALL STUDS ENCLOSE THE MAIN
BATHROOM IN A DWELLING UNIT, REINFORCEMENT SHALL BE INSTALLED TO PERMIT

THE FUTURE INSTALLATION OF GRAB BARS AS FOLLOWS:

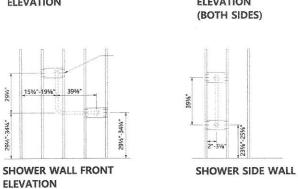

GRAB BAR INSTALLATION SPECIFICATION:

1. BESIDE WATER CLOSET L-SHAPED GRAB BAR WITH 750MM LONG HORIZ. AND VERT. COMPONENTS MOUNTED W/ HORIZ. COMPONENT 750MM A.F.F. AND THE VERTICAL COMPONENT 150MM IN FRONT OF TOILET BOWL

2. BEHIND WATER CLOSET MIN. 600MM LONG GRAB BAR MOUNTED HORIZONTALLY ON WALL 840MM TO 920MM ABOVE THE FLOOR AND 150MM ABOVE THE WATER TANK IF APPLICABLE.

3. BEHIND BATHTUB THE FULL LENGTH OF THE TUB (MIN 1200MM LONG) GRAB BAR MOUNTED HORIZONTALLY ON THE WALL,

APPROX. 250MM ABOVE TUB RIM. 4. BOTH END WALLS OF TUB A MIN, 1200MM LONG GRAB BAR MOUNTED VERTICALLY ON WALL WITH

5. BEHIND SHOWER AN L-SHAPED GRAB BAR WITH 1000MM LONG HORIZONTAL COMPONENT AND 750MM LONG VERTICAL COMPONENT, MOUNTED 750MM TO 870MM ABOVE THE FINISHED FLOOR AND 400MM TO 500MM OFF OF WALL THAT SHOWER SIDE WALL GRAB BAR IS LOCATED.

6. SHOWER SIDE WALL A MIN. 1000MM LONG GRAB BAR MOUNTED VERTICALLY ON THE WALL, 600MM TO 650MM ABOVE THE FINISHED FLOOR AND 50MM TO 80MM FROM EDGE OF WALL

ADJACENT TO CLEAR FLOOR AREA. GRAB BAR ATTACHMENT NOTES: *2"X8" WOOD BLOCKING BETWEEN WALL STUDS

ND 3-3 1/2" SPIRAL NAILS OR SCREWS BOTH SIDES

*GRAB BARS SHALL NOT OBSTRUCT THE USE OF

PLOT FORMAT SIZE: DRAWN BY: Brian Rintjema 24 X 36 DATE: SCALE: APRIL 30, 2024 As Noted SHEET NO.

